



Site Address:

157-159 High St, Southend-on-Sea SS1 1LL

Client:

Pilingstone Ltd

Sheet Title:

Location Plan

File Name

U-PP - LP001

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Scale Page As indicated 1.1	Sheet Size A3

Any inaccuracies or errors to be reported to the architect/surveyor immediately and prior to any work commencing.
All dimensions to be verified on site.
All work to comply with British Standards Code of practice. All work to comply with British Standards Code of Practice.
All external surfaces and materials to match existing.


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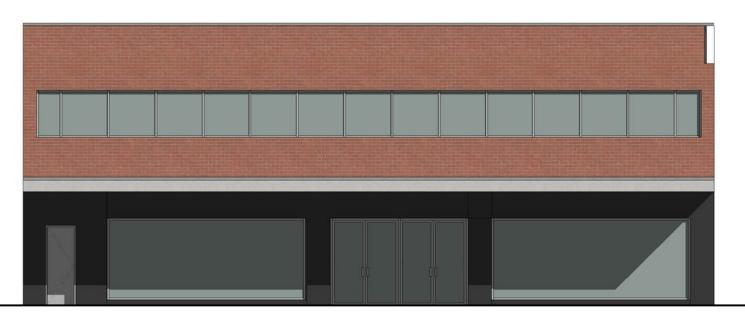
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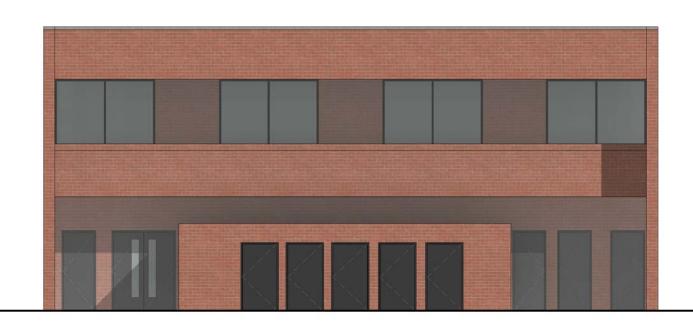
Ground Floor



	File Name U-PP - EP(Client: Pilingstor	ne Ltd	2 0 2 4 6 8 10 SCALE 1:200 m	www.upp-planning.co.uk info@upp-planning.co.uk 0208 202 9996 URBAN PLANNING PRACTICE	This drawing and all information provided within it is the copyright of URBAN PLANNING PRACTICE and reproduction without prior consent is stricly forbidden.	Date: 10/2018	Revision:	Notes:	INT:
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7	Scale 1 : 200	Page 2.1	Sheet Size A3	157-159 High St, Southend-on-Sea	Any inaccuracies or errors to be reported to the architect/surveyor immediately and prior to any work commencing. All dimensions to be verified on site. All work to comply with British Standards Code of practice.	Existing Plans				
				SS1 1LL	All external surfaces and materials to match existing.					



Existing Front Elevation

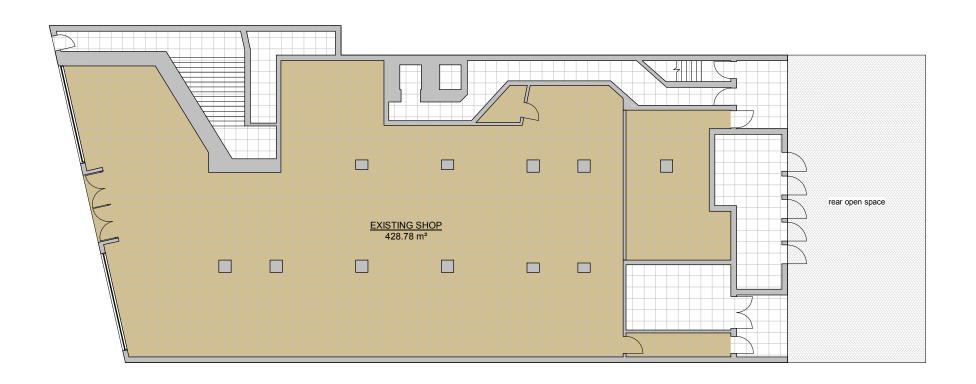

Existing Rear Elevation



U-PP - EE001

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Scale

1:100

Client: Pilingstone Ltd

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2.3

1 2 3 4 SCALE 1:100



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Existing Elevations

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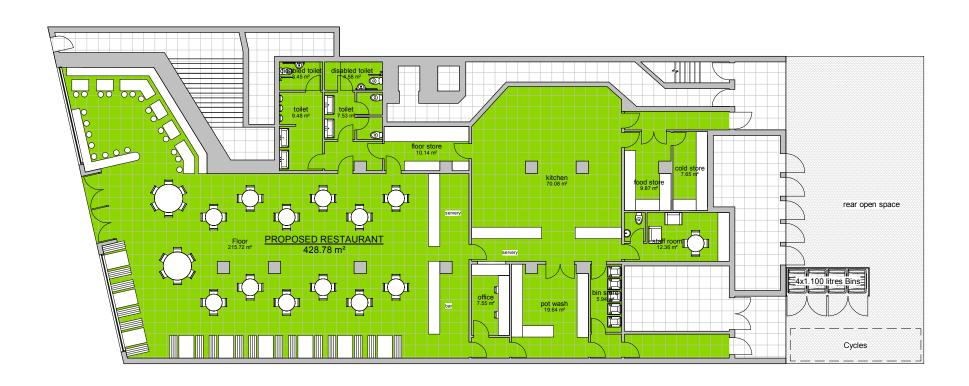
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Proposed Ground Floor




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U-PP - PP001

Client:

Pilingstone Ltd

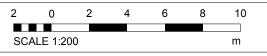

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Proposed Plans

INT: 10/2018


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Proposed Ground Floor - Systems

(SD) SMOKE DETECTOR

9LT. WATER FIRE EXTIGUISHER

CARBON DIOXIDE FIRE EXTIGUISHER

FEKC FIRE ESCAPE KEEP CLEAR

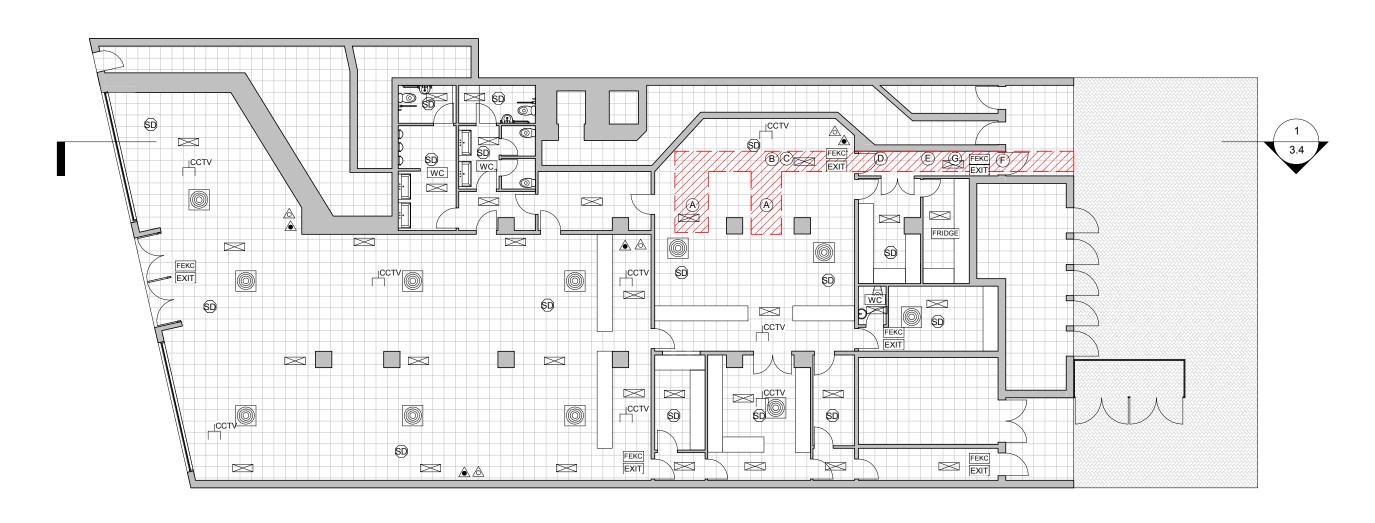EXIT INTERNALLY ILLUMINATED FIRE ESCAPE SIGN (BS 5266)

CLOSED CIRCUIT TV

FRIDGE FRIDGES

 \triangle

 \geq SAFETY LIGHTS

EXIT INTERNALLY ILLUMINATED FIRE ESCAPE SIGN (BS 5266)

WC WC AREA

 $\widehat{\mathsf{A}}$ COOKING PARTICULATES AND ODORUS

 \bigcirc B COMPANY GREASE FILTER

(C) ESP - PARTICULATE CONTROL UNIT ESP 3000

(D) CARBON UNIT 12x SITESAFA PA 240924

(E) AEROFOIL 56JM FAN

(F) ALNOR SIL *100-300 100 200 350 SILENCER

EXTRACTION SYSTEM



U-PP -PP002 Pilingstone Ltd

Client:

File Name

1.5 6 7.5 SCALE 1:150



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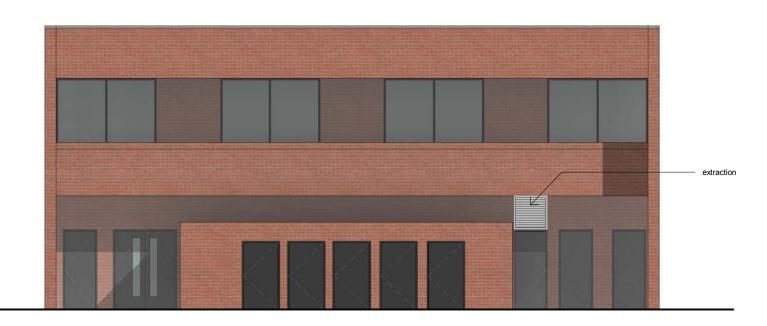
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Systems

10/2018	REV 4	



Proposed Front Elevation



Proposed Rear Elevation



File Name
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Scale

1:100

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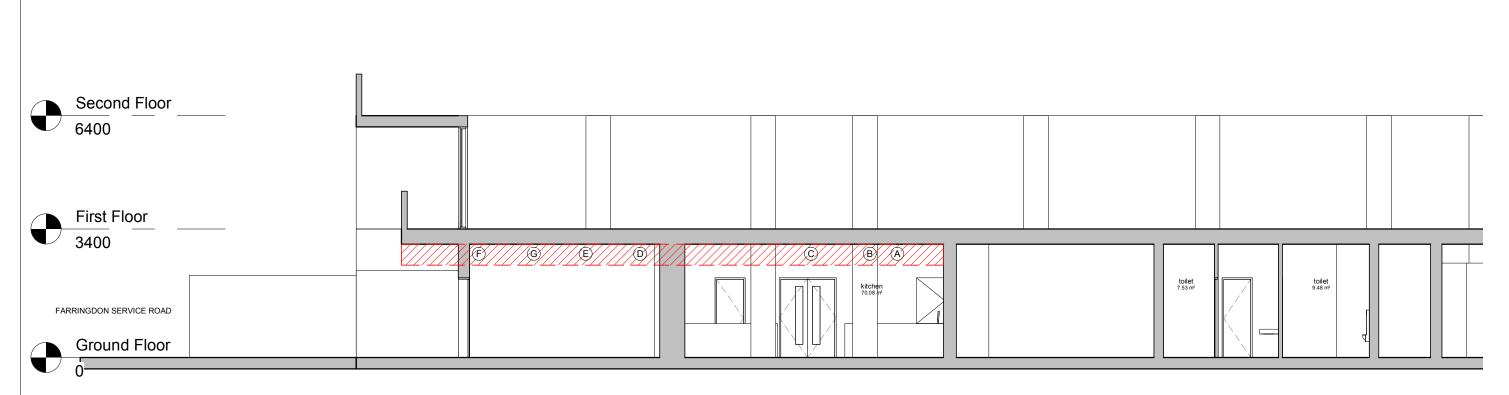
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Proposed Elevations



Section 1

The GreenTeck OT-64G is a high efficiency ozone generator unit, ideal for use in commercial kitchens, food processing plants and factories. The unit is installed between the extraction point and the exhaust fan, external to the ductwork, making servicing and maintenance much easier. The unit eliminates smells by oxidising pathogens in the exhaust pipes and also prevents the build-up of residue in the ductwork, preventing failures in fans and fire hazards.

	000
Maximum Power Requirement	343W
Voltage	Single Phase 240 V
Rated Current	1.5A
Fuse Rating	ЗА
Mains Frequency	50/60 Hz
Weight	~9kg
Dimensions (depth x width x height)	300mm x 340mm x 490mm
Reactor	64 grams / hour
Air flow rate	1000 m3/h





COOKING PARTICULATES AND ODORUS

 \bigcirc B COMPANY GREASE FILTER

(C) ESP - PARTICULATE CONTROL UNIT ESP 3000

CARBON UNIT 12x SITESAFA PA 240924

(E) AEROFOIL 56JM FAN

ALNOR SIL *100-300 100 200 350 SILENCER

GREENTECK OT-64G OZONE GENERATOR



EXTRACTION SYSTEM

GREENTECK OT-64G OZONE GENERATOR

ALNOR SIL *100-300 100 200 350 SILENCER

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